

Woodside Health and Tennis

2000 W. 47th Place, Westwood, KS 66205

SCHEMATIC DEVELOPMENT PACKAGE | August 19th, 2011

PROJECT LOCATION (NTS):



2000 W. 47th Place, Westwood, KS 66205



CLIENT:
TANNER & WHITE

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BUILDING DATA:

ADOPTED CODES:
Building Codes: 2003 International Building Code (IBC) 2003 International Existing Building Code (IEBC) 2003 International Fuel Gas Code (IFGC)
Plumbing Code: 2003 International Plumbing Code (IPC)
Mechanical Code: 2002 National Mechanical Code (IMC)
Electrical Code: 2002 National Electric Code (NEC)
Fire Prevention: 2003 International Fire Code (IFC)
Other Codes:

BUILDING DATA:
Use Groups: Fitness Club A-3 Parking Garage S-2
Type of Construction: Sprinklered
Number of Stories: 2
Occupancy Load*: Lower Level: 445 Main Level: 303 Total: 748
Required Exits:
EXISTING BUILDING GROSS SQUARE FOOTAGES: LOWER LEVEL: 13,444 S.F. MAIN LEVEL: 13,089 S.F. UPPER LEVEL: 1,304 S.F. TOTAL: 27,837 S.F.
PROPOSED ADDITION AT ENTRANCE: 821 S.F. TOTAL WITH ADDITION AT ENTRANCE: 28,658 S.F.
NEW ADDITION GROSS SQUARE FOOTAGES: LOWER LEVEL: 21,584 S.F. MAIN LEVEL: 17,843 S.F. TOTAL: 39,427 S.F.
NEW ADDITIONAL PARKING S.F. / STALL COUNT: NEW PARKING (BELOW TENNIS COURTS): 58,663 S.F. / 161 CARS NEW PARKING (SURFACE): 30,095 S.F. / 65 CARS TOTAL: 88,758 S.F. / 226 CARS

*See A001 for occupancy loads of individual spaces.

REVISION SCHEDULE:		
NO.	DATE	ISSUE

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TITLE:

Drawn By: JOT
Project Number: 10114

COVER SHEET

NUMBER:

A000

GENERAL NOTES:

For definitions of proper nouns used in these general notes (i.e. Owner, Architect, Contractor, Work, etc.), refer to AIA Document A201-2007 General Conditions of the Contract for Construction.

1. All work and materials furnished shall comply with ALL applicable building codes, including, but not limited to The State of Kansas Regulations, the regulations of the National Board of Fire Underwriters, National Fire Protective Association Requirements and all Federal, State, and Municipal authorities having jurisdiction over the work and the INTERNATIONAL BUILDING CODE (IBC)- 2003.

2. Contractor is responsible for securing and obtaining all necessary permits, approvals, and inspections and paying all applicable fees for all Subcontractors.

3. Contractor must comply with all appropriate municipal and regulatory agencies, codes and requirements. The contractor shall submit certificates of insurance in accordance with building requirements and shall include a hold harmless clause for the owner, building management, and the Architect.

4. Contractor shall provide controlled inspections as required for the City Building Department approval. All controlled inspections are to be performed by licensed professionals and the cost of these services is to be paid by the contractor.

5. The submission of a proposal by the Contractor will be construed as evidence that a careful and thorough examination of the premises has been made and later claims for labor, materials or equipment required or difficulties encountered, which could have been foreseen had such an examination been made, will not be recognized. The submission of a proposal by the Contractor shall also constitute a representation that the Contractor has checked and verified all quantities, work and materials involved and that he or she shall take responsibility or any deficiencies therein.

6. Before ordering any materials or doing any work, each Subcontractor shall verify all measurements at the building and shall be responsible for correctness of same. No extra charge or compensations will be allowed on account of any difference between actual dimensions and the measurements indicated on the drawings; any discrepancies between the drawings and field conditions which may be found shall be submitted to the Architect for consideration and clarification before proceeding with the work. The Contractor shall be responsible for any deviations from the Contract Documents.

7. All the Architect's drawings and construction notes are complimentary and what is called for by either will be binding as if called for by all; any work shown or referred to in any one drawing shall be furnished by the Contractor as shown on all drawings. Whenever an item is specified and/or shown on the drawings by detail or reference it shall be considered typical for other items which are obviously intended to be the same, even though not so designated or specifically named but do serve the same function.

8. Full size or large scale details or drawings shall govern small scale drawings which they are intended to amplify. Details or conditions indicated for a portion of the work but not carried out fully for other portions shall apply throughout to all similar portions except as otherwise specifically noted. In every case a more expensive item or method shall be assumed over a less expensive one and dimensions shall be figured rather than determined by rule or scale.

9. The character and scope of the Work are illustrated by the Drawings. To interpret and explain the Drawings, other information deemed necessary by the Architect will be furnished to the Contractor when and as required by the Work. It is to be understood that the said additional drawings are to be of equal force as the original drawings, and shall be considered as forming a part of this set.

10. The Contractor shall abide by and comply with the true intent and meaning of the drawings and notes taken as a whole and shall not avail himself or herself of any obvious errors or omissions, should any exist. Should any error or discrepancy appear or any doubt arise as to the true meaning of the drawings or notes, the contractor shall bring such items to the attention of the Architect before submission of a bid or proposal for explanation or correction of same. After the submission of proposal, the contractor will be held responsible for all such items.

11. The work to be performed consists of furnishing all labor, equipment, tools, transportation, supplies, fees, materials, and services in accordance with these General Notes and Construction Documents, and includes performing all operations necessary to construct and install complete, in satisfactory condition, the various materials and equipment at the locations shown within the Construction Documents. It is intended that the drawings include everything requisite and necessary to finish the entire work properly, notwithstanding the fact that every item necessarily involved may not be specifically mentioned or shown. Any item which may be reasonably construed as incidental to the proper and satisfactory completion of the work in accordance with the intent of these notes and drawings is hereby included.

12. The contractor shall notify the Architect immediately if he cannot for any reason comply with all the requirements of these General Notes and Construction Documents.

13. The contractor shall submit in writing all proposals for additional work to the Architect for review and approval. No additional work by the Contractor or its agents is to proceed until a signed authorization to proceed is returned to Contractor.

14. Work affected by changes proposed in any revised drawings or other documents issued to the Contractor shall not be executed unless changes are accompanied by letter of authorization from the owner to proceed accordingly. In cases where instructions accompanying an issue of revised drawings or specifications request estimates of cost, such estimates shall be prepared and submitted promptly to the owner in order not to affect the progress of the work.

15. Payment will not be made to the Contractor on changes or extras unless they are approved in writing by Owner or Owner's Representative.

16. The Project has been designed and detailed for the specific materials and equipment specified. No substitutions shall be made without the express written consent of the Architect. If the specified material is not available, the contractor shall propose an alternate material and shall provide drawings, samples, specifications, manufacturer's literature, performance data, etc. in order that the Architect can evaluate the proposed substitution. If the substitution affects a correlated function, adjacent construction, or the work of any other contractor or trade, the necessary changes and modifications to the affected work shall be accomplished by the contractor at no additional expense to the owner. No requests for substitutes will be entertained by the Architect due to contractor's failure to order materials in a timely manner.

17. All materials required for the performance of this work shall be new and of the best quality of the kinds specified. The use of old or second-hand materials is strictly forbidden, except for locations on the drawings that refer to removal and relocation of materials or equipment. All materials shall be used in accordance with the manufacturer's specifications. The Contractor shall submit all product warranties. The Contractor shall warranty all work as per state and/or local jurisdiction regulations. Upon request, the manufacturer's representative shall go to the site and instruct the mechanics in the use of the materials or shall supervise their use.

18. The standard specifications of the manufacturers approved for use in the project are hereby made a part of these notes with the same force and effect as though herein written out in full, except that wherever the drawings require heavier members, better quality materials or are otherwise more stringent, those more stringent requirements shall govern.

19. The Contractor shall submit all fabrication shop drawings, samples, and fixture cuts for the Architect's review as required and/or indicated on the drawings. The Architect's review shall not be construed as an indication that the submittal is correct or suitable nor that work represented by submittal complies with the drawings, except as to the matters of finish, color, and other aesthetic matters. The duties noted above do not relieve the Contractor from responsibility to coordinate all trades and to check quantities and dimensions against conditions in the field. Contractors shall assume responsibility for all errors on their drawings.

20. The Contractor shall submit all shop drawings, complete with manufacturer's equipment cuts, for approval by the Architect prior to commencement of work.

21. When "approved equal", "equal to", or other general qualifying terms are used it shall be based upon the review and approval by the Owner or the Owner's Representative. No material substitutions shall be made without first informing the Owner. Submit substitute materials specifications and samples to the Architect for approval, in writing prior to commencement of work.

22. Any materials delivered or work performed, contrary to the drawings and specifications and approved shop drawings, shall be removed by the Contractor at his own expense, and the same shall be replaced with other materials or work satisfactory to the Architect. The Contractor shall also assume the cost of replacing the work which may be disturbed by the Contractor.

23. The Contractor shall be responsible for properly and accurately laying out the work and for the lines and measurements herein. The contractor shall establish necessary reference lines and permanent bench marks from which building lines and elevation shall be taken. Heights of all work called for "A.F.F." including but not limited to soffits, ceilings, doors, and hollow metal shall be true and level within a maximum tolerance of 1/8" overall throughout the entire project.

24. All HVAC, plumbing, sprinkler and electrical lines are to be coordinated so that no conflicts occur. Any conflicts which result in a relocation of a finished surface must be brought to the attention of the Architect/Engineer prior to installation.

25. Unless otherwise noted, the Contractor shall provide a one-year warranty covering all work performed and equipment installed, from the time of Substantial Completion.

26. Contractor shall carefully remove and protect items indicated by the Owner or in the Construction Documents to be saved for re-use.

27. The Contractor shall keep the Architect informed of the progress of the Work. No work shall be closed or covered until it has been duly inspected and approved. Should uninspected work be covered the contractor shall, at their own expense, uncover all such work so that it can be properly inspected and after such inspection, shall properly be repaired and replaced.

28. All work shall be subject to final inspection by the Architect and acceptance by the Owner.

29. Contractor is responsible for the safety and protection of workers, public, and property.

30. A copy of the latest signed and sealed set of Construction Documents shall be kept at the job site for review by the Owner, the Owner's Representative, the Architect, or inspectors.

31. The Contractor shall have a competent superintendent on the premises at all times when the work is in progress.

32. All plumbing and electrical work shall be performed by persons licensed in their trades.

33. The Contractor shall coordinate their own work with the work of all other Contractors and Subcontractors, whether their own or those on separate contract. Prior to commencing work, the Contractor shall provide a work schedule to show estimated commencement and completion dates of each trade and also identifying long lead items. Contractor shall be responsible for giving all trades such information, plans or details as may be required for the proper installation of their work. All materials shall be ordered sufficiently ahead of time so that work can proceed on schedule. No substitution of materials will be accepted because of failure to do order material on time.

34. The owner reserves the right to let other contacts in connection with the work of the project. The contractor shall be responsible for coordination of work with other contractors. The contractor shall afford other contractors reasonable opportunity for the introduction and storage of their materials and equipment and the execution of their work.

35. The Contractor is responsible for the following conditions:
A. The premises and the job site shall be maintained in a reasonably neat and orderly condition and kept free from accumulations of waste materials and rubbish during the entire construction period. Remove crates, cartons and other flammable waste materials or trash from the work areas at the end of each working day. Contractor to control cleaning to prevent dirt or dust from leaving the job site and infiltrating areas not involved in the project. No material or debris storage shall be permitted at the street or sidewalk at any time.

B. Electrical closets, pipe and duct shafts chases, furred spaces and similar spaces shall be cleaned and left free from rubbish loose plaster, mortar drippings, extraneous construction materials, dirt and dust.

C. Contractor shall protect and be responsible for the existing structure, facilities and improvements adjoining the area under this contract. Any disturbance or damage to adjoining property resulting directly or indirectly from the contractor's operation shall be promptly restored, repaired or replaced to the satisfaction of the client at no additional cost.

D. Clean up immediately upon completion of each trade's work.

E. This cleaning includes the removal of trash and rubbish from these areas, broom cleaning of floors, the removal of any plaster, mortar, dust and other extraneous materials from finish surfaces, including but not limited to miscellaneous metal, woodwork, plaster, glass, gypsum drywall, masonry, concrete, mechanical and electrical equipment, piping ductwork, conduit, and surfaces visible after permanent fixtures, induction unit covers, grilles, registers, and other such fixtures or devices are in place.

F. In addition to the cleaning specified above and the more specific cleaning which may be required in various sections of the specifications the premises shall be prepared for occupancy by:

(i) a thorough cleaning throughout including washing or cleaning by other approved methods of all floors and surfaces on which dirt or dust has collected and by washing glass, removing all paint, foreign material, and stains thereon.

(ii) providing and maintain adequate runner strips of non-staining reinforced kraft building paper on finished floors as required for protection.

(iii) leaving all fixtures and equipment in an undamaged, bright, clean, polished condition.

(iv) clean and polish all hardware and all other metal work.

(v) do all other cleaning as required to turn the premises over to the owner in a spotless and orderly condition.

36. The Owner reserves the right to accept or refuse any bids/proposals from any Contractor or Subcontractor without exception.

37. The Contractor is Responsible for the following conditions related to safety of public and property.

A. Institute and maintain safety measures and provide all equipment or temporary construction necessary to safeguard all persons and property affected.

B. Structures, devices, or construction equipment shall not be loaded in excess of their design capacity.

C. Before using construction equipment or devices, same shall be inspected by the person supervising the work, and defects or unsafe conditions shall be promptly corrected before use.

D. Determine location, protect and safeguard all utilities on or adjacent to site. Notify all utility companies and building management as required.

E. Maintain fire preventive, sanitary and safety facilities.

F. All machines, tools, service lines and conduits shall be shielded or barricaded to provide safety and prevent contact by the public.

G. No materials shall be dropped or thrown outside the exterior walls of the building.

H. Areas used by the public shall be maintained free from debris, equipment, materials.

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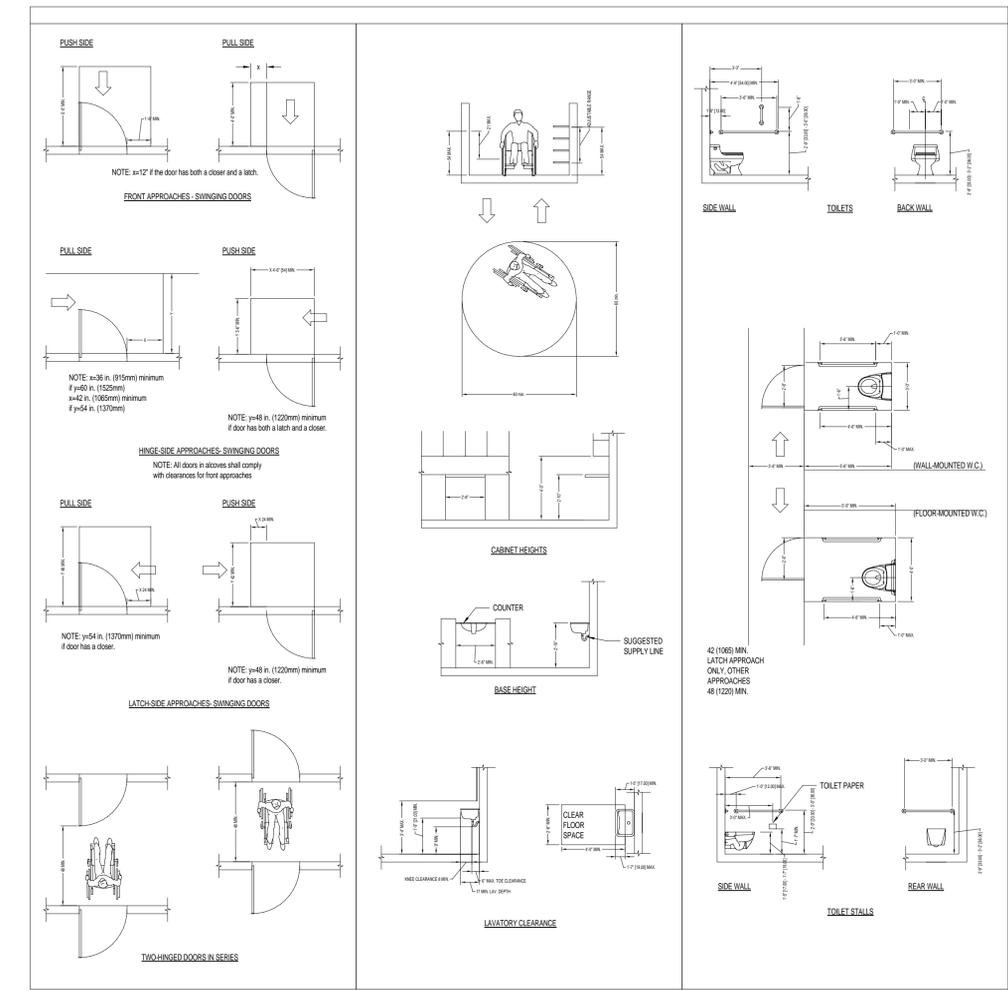
ABBREVIATIONS:

TEXT SYMBOLS	GA	Gauge	R	Riser or Radius
& And	GALV	Galvanized	RA	Return Air
Angle	GB	Grab Bar	RCP	Reflected Ceiling Plan
At	GC	General Contractor	RD	Roof Drain
Centerline	GEN	General	RE	Reference
Channel	GFRC	Glass Fiber Reinforced Concrete	RECP	Receptacle
Diameter or Round	GL	Glass	REF	Refrigerator
# Number or Pound	GR	Guardrail	REFL	Reflected
Per	GPM	Gallons per minute	REINF	Reinforced
Perpendicular or Structural	GR	Gypsum Board	REQD	Required
Plate	GWB	Gypsum Board	RFG	Roofing
Plus or Minus	H	Hose Bibb	REV	Revision
Square Foot (feet)	HB	Hollow Core	HCP	Handicapped
Times	HD	Head	RO	Rough Opening
A	HDW	Hardware	RTU	Roof Top Unit (Re: Mech)
ACOUST	HDWD	Hardwood	S	South
AD	HDWR	Hardware	SAN	Sanitary
ADH	HEWC	Handicap Electric Water Cooler	SC	Solid Core
ADJ	HLAV	Handicap Lavatory	SCHED	Schedule
AF	HM	Hollow Metal	SECT	Section
AFB	HR	Handrail	SF (SQ FT)	Square Foot (Feet)
AHU	HORIZ	Horizontal	SH	Shower
ALUM	HT	Height	SHT	Sheet
ALT	HYD	Hydrant	SIM	Similar
AP	IC	Intercom	SMLS	Seamless
APPROX	ID	Inside Diameter/Dimension	SP	Spacing
APPD	IN	Inch	SPEC	Specification
ARCH	INDIV	Individual	SPHD	Sprinkler Head
ASPH	INFO	Information	SPKR	Speaker
AV	INSUL	Insulation	SPKR	Sprinkler
B	INT	Interior	SS	Stainless Steel
BEY	JAN	Janitor	STD	Standard
BD	JOIST	Joist	STL	Steel
BK	JT	Joint	STO	Storage
BLDG	STRUC	Structure/Structural	SUSP	Suspended
BLDK	K	Kitchen	SY (SQYD)	Square Yard(s)
BM	KIT	Knockout	SYM	Symmetrical
BO	KO	Knockout	SYS	System
BOT	L	Long Length	T	Tread
BRG	LAM	Laminate	T&B	Top and Bottom
BSMT	LAV	Lavatory	T&G	Tongue and Groove
BTWN	LGTH	Length	TEL	Telephone
BRKT	LKR	Locker	TEMP	Tempered
CB	LT	Light (Lighting)	TOC	Top of Concrete
CB Chalk Board	LWC	Light Weight Concrete	TOD	Top of Deck
CC Center to Center	M	Meter	TOM	Top of Masonry
CG Corner Guard	MAS	Masonry	TOP	Top of Parapet
CI Cast Iron	MAS BLK	Masonry Block	TERM	Terminate
CIP Cast-in-Place	MATL	Material	TOS	Top of Slab or Top of Steel
CJ Control Joint	MAX	Maximum	TOW	Top of Wall
CLG Ceiling	MECH	Mechanical	TRANS	Transformer
CLO Closet	MFG	Manufacturing	TS	Tube Steel
CMU Concrete Masonry Unit	MFR / MANUF	Manufacturer	TV	Television
CO Cleanout	MH	Manhole	TYP	Typical
COL Column	MI	Mirror	U	Urinal
COMB Combination	MIN	Minimum	UNO	Unless Noted Otherwise
CONC Concrete	MISC	Miscellaneous	US	Utility Shelf
CONN Connection	MO	Mounted	V	Vapor Barrier
CONSTR Construction	MTG HT	Mounting Height	VB (VPRBR)	Vapor Barrier
CONT Continuous	MTL	Metal	VENT	Ventilation
CONTR Contractor	MULL	Mullion	VERT	Vertical
CORR Corridor	N	North	VEST	Vestibule
CSK Countersunk	N/A	Not Applicable	VTR	Vent Thru Roof
CTR Center	NIC	Not in Contract	VCT	Vinyl Composite Tile
DBL Double	NO	Number	WVC	Vinyl Wall Covering
DCMU Decorative Concrete Masonry Unit	NOM	Nominal	W	West or Wide or Width
DEPT Department	NPS	National Pipe Standard	WC	Water Closet
DF Drinking Fountain	NTS	Not To Scale	W/	With
DIA Diameter	OA	Overall	WI	Within
DIAG Diagonal	OC	On Center	WO	Without
DIM Dimension	OD	Outside Diameter/Dimension	WD	Wood
DN Down	OFF	Office	WDW	Window
DR Door	OH	Opposite Hand	WF	Wide Flange
DS Down Spout	OPNG	Opening	WGT	Weight
DTL Detail	OPP	Opposite	WH	Wall Hydrant
DWG(S) Drawing(s)	ORD	Overflow Roof Drain	WP	Waterproof
E	OTS	Open to Structure	WT	Structural T Section
EA Each	OH	Overhead	WWF / WWM	Weided Wire Fabric
EJ Expansion Joint	OZ	Ounce	X	by (i.e. 2x4)
EL Elevation	PA	Public Address	Y	Yard
ELEC Electrical	PAR	Parallel	YD	Yard
ELEV Elevator	PART	Partition		
ENG Electronic News Gathering	PC	Precast Concrete		
EOS Edge of Slab	PCP	Portland Cement Plaster		
EQ Equal	PERP	Perpendicular		
EQUIP Equipment	PL	Property Line		
EWC Electric Water Cooler	PLM	Plastic Laminated		
EXH Exhaust	PLAS	Plaster		
EXP Expansion	PLBG	Plumbing		
EXIST Existing	PLYWD	Plywood		
EXT Exterior	PLNG	Paneling		
F	PNL	Panel		
FA Fire Alarm	POL	Polished		
FD Floor Drain	PR	Pair		
FND Foundation	PSF	Per Square Foot		
FE Fire Extinguisher	PSI	Per Square Inch		
FEC Fire Extinguisher Cabinet	PREFAB	Prefabricated		
FF Finished Floor	PSS	Photostrobe Sync Place		
FH Fire House	PT	Point		
FFE Furnishing, Fixtures and Equipment	PTD	Painted		
FHC Fire Hose cabinet	QTY	Quantity		
FKT Fixture				
FVC Fire Valve Cabinet				
FIN Finish				
FL Floor				
FLASH Flashing				
FOC Face of Concrete				
FOF Face of Finish				
FOS Face of Stud				
FS Floor Sink				
FR (FRM) Frame				
FT Foot or Feet				
FTG Footing				
FURR Furring				
FV Field Verify				


NEW CONSTRUCTION ROOM SCHEDULE/OCCUPANCY:

NO.	NAME	AREA	OCCUPANT LOAD	OCCUPANCY
143	TREAT.	100 SF	100	1
144	TREAT.	102 SF	100	1
145	TREAT.	99 SF	100	1
146	TREAT.	142 SF	100	2
147	TREAT.	101 SF	100	2
148	PRO SHOP	329 SF	30	11
149	HALL	2918 SF	-	-
150	OFFICE	Not Placed	-	-
153	FITNESS EVAL.	264 SF	-	-
154	FITNESS OFFICE	357 SF	100	3
155	KAISER	37 SF	100	1
156	GYM	7313 SF	50	142
157	SPECIALTY GYM	1962 SF	50	30
158	STORAGE	Not Placed	-	-
159	MENS LOCKER ROOM	656 SF	50	13
160	WOMENS LOCKER ROOM	683 SF	50	14
161	LOUNGE	618 SF	-	-
162	POOL DECK	1429 SF	15	100
163	POOL	2450 SF	50	48
164	MECH. / STORAGE	447 SF	300	2
165	STORAGE	214 SF	300	1
166	OFFICE	102 SF	-	-
167	RAMP	416 SF	-	-
168	OFFICE	Not Placed	-	-
169	LOUNGE	114 SF	-	-
170	STAIR	Not Placed	-	-
171	PARKING	56692 SF	-	-
175	Room	61 SF	-	-
176	CARDIO	2507 SF	-	-
177	OFFICE	102 SF	-	-
178	YOGA STUDIO	2089 SF	-	-
179	RECEPTION	98 SF	-	-
180	SPORTS MED.	117 SF	-	-
181	TREAT.	129 SF	-	-
182	STORAGE	33 SF	-	-
183	DRESSING ROOM	27 SF	-	-
184	STAFF / OFFICE	59 SF	-	-
185	STAFF BREAKROOM	189 SF	-	-
215	MENS	150 SF	-	-
216	CONF.	565 SF	-	-
219	CLOSET	29 SF	-	-
220	ELEVATOR	29 SF	-	-
221	TRAINING ROOM	121 SF	-	-
225	AEROBIC AREA	1204 SF	-	-
226	LOUNGE	478 SF	15	49
227	TRAINER'S DESK	84 SF	100	1
228	KIT LOCKERS	126 SF	100	2
229	OFFICE	Not Placed	100	2
230	OFFICE	Not Placed	-	-
231	HALL	1621 SF	-	-
235	HALL	267 SF	-	-
236	STRETCHING	634 SF	50	13
237	SPINNING	1013 SF	50	21
238	GROUP EXERCISE	2608 SF	50	51
239	STORAGE	359 SF	300	2
240	MENS W.C.	178 SF	-	-
241	WOMENS W.C.	178 SF	-	-
242	MULTI-PURPOSE STUDIO	1353 SF	50	26
243	MULTI-PURPOSE STUDIO	2046 SF	50	38
244	PRIVATE YOGA	Not Placed	50	5
245	YOGA STUDIO	Not Placed	50	39

ACCESSIBILITY DIAGRAMS:



SYMBOLS LEGEND:

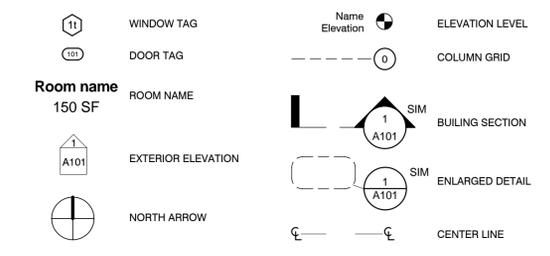

REVISION SCHEDULE:

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NOT FOR CONSTRUCTION

TITLE:
 Drawn By: JDT
 Project Number: 10114

NOTES

NUMBER:

A001

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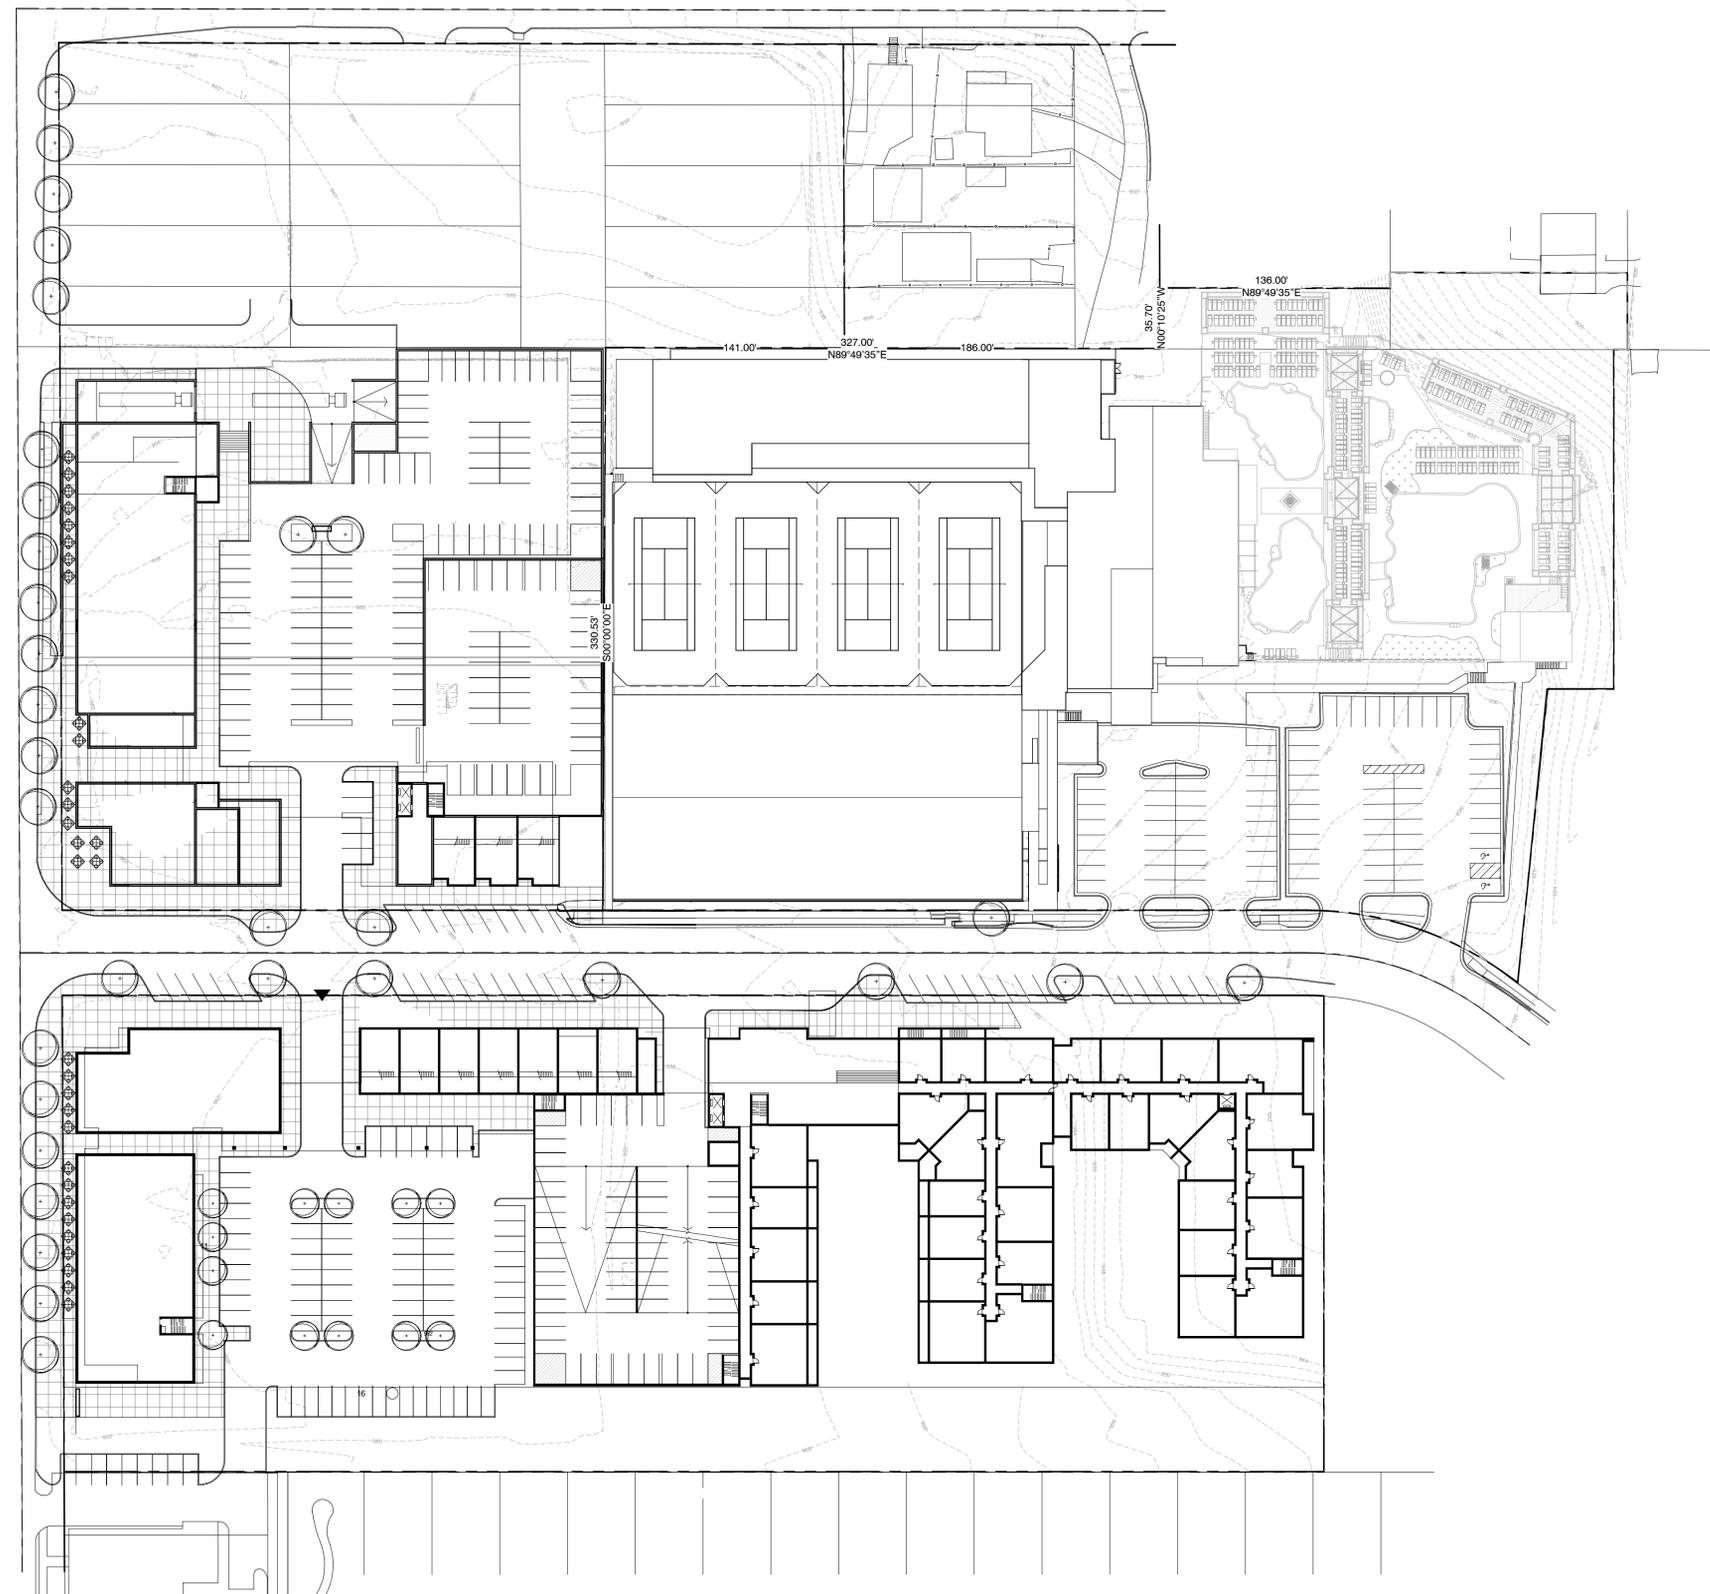
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TITLE:
 Drawn By: JOT
 Project Number: 10114
SITE PLAN - WOODSIDE COMPLEX

NUMBER:
A101



1 SITE PLAN - WOODSIDE COMPLEX
 1" = 50'-0"



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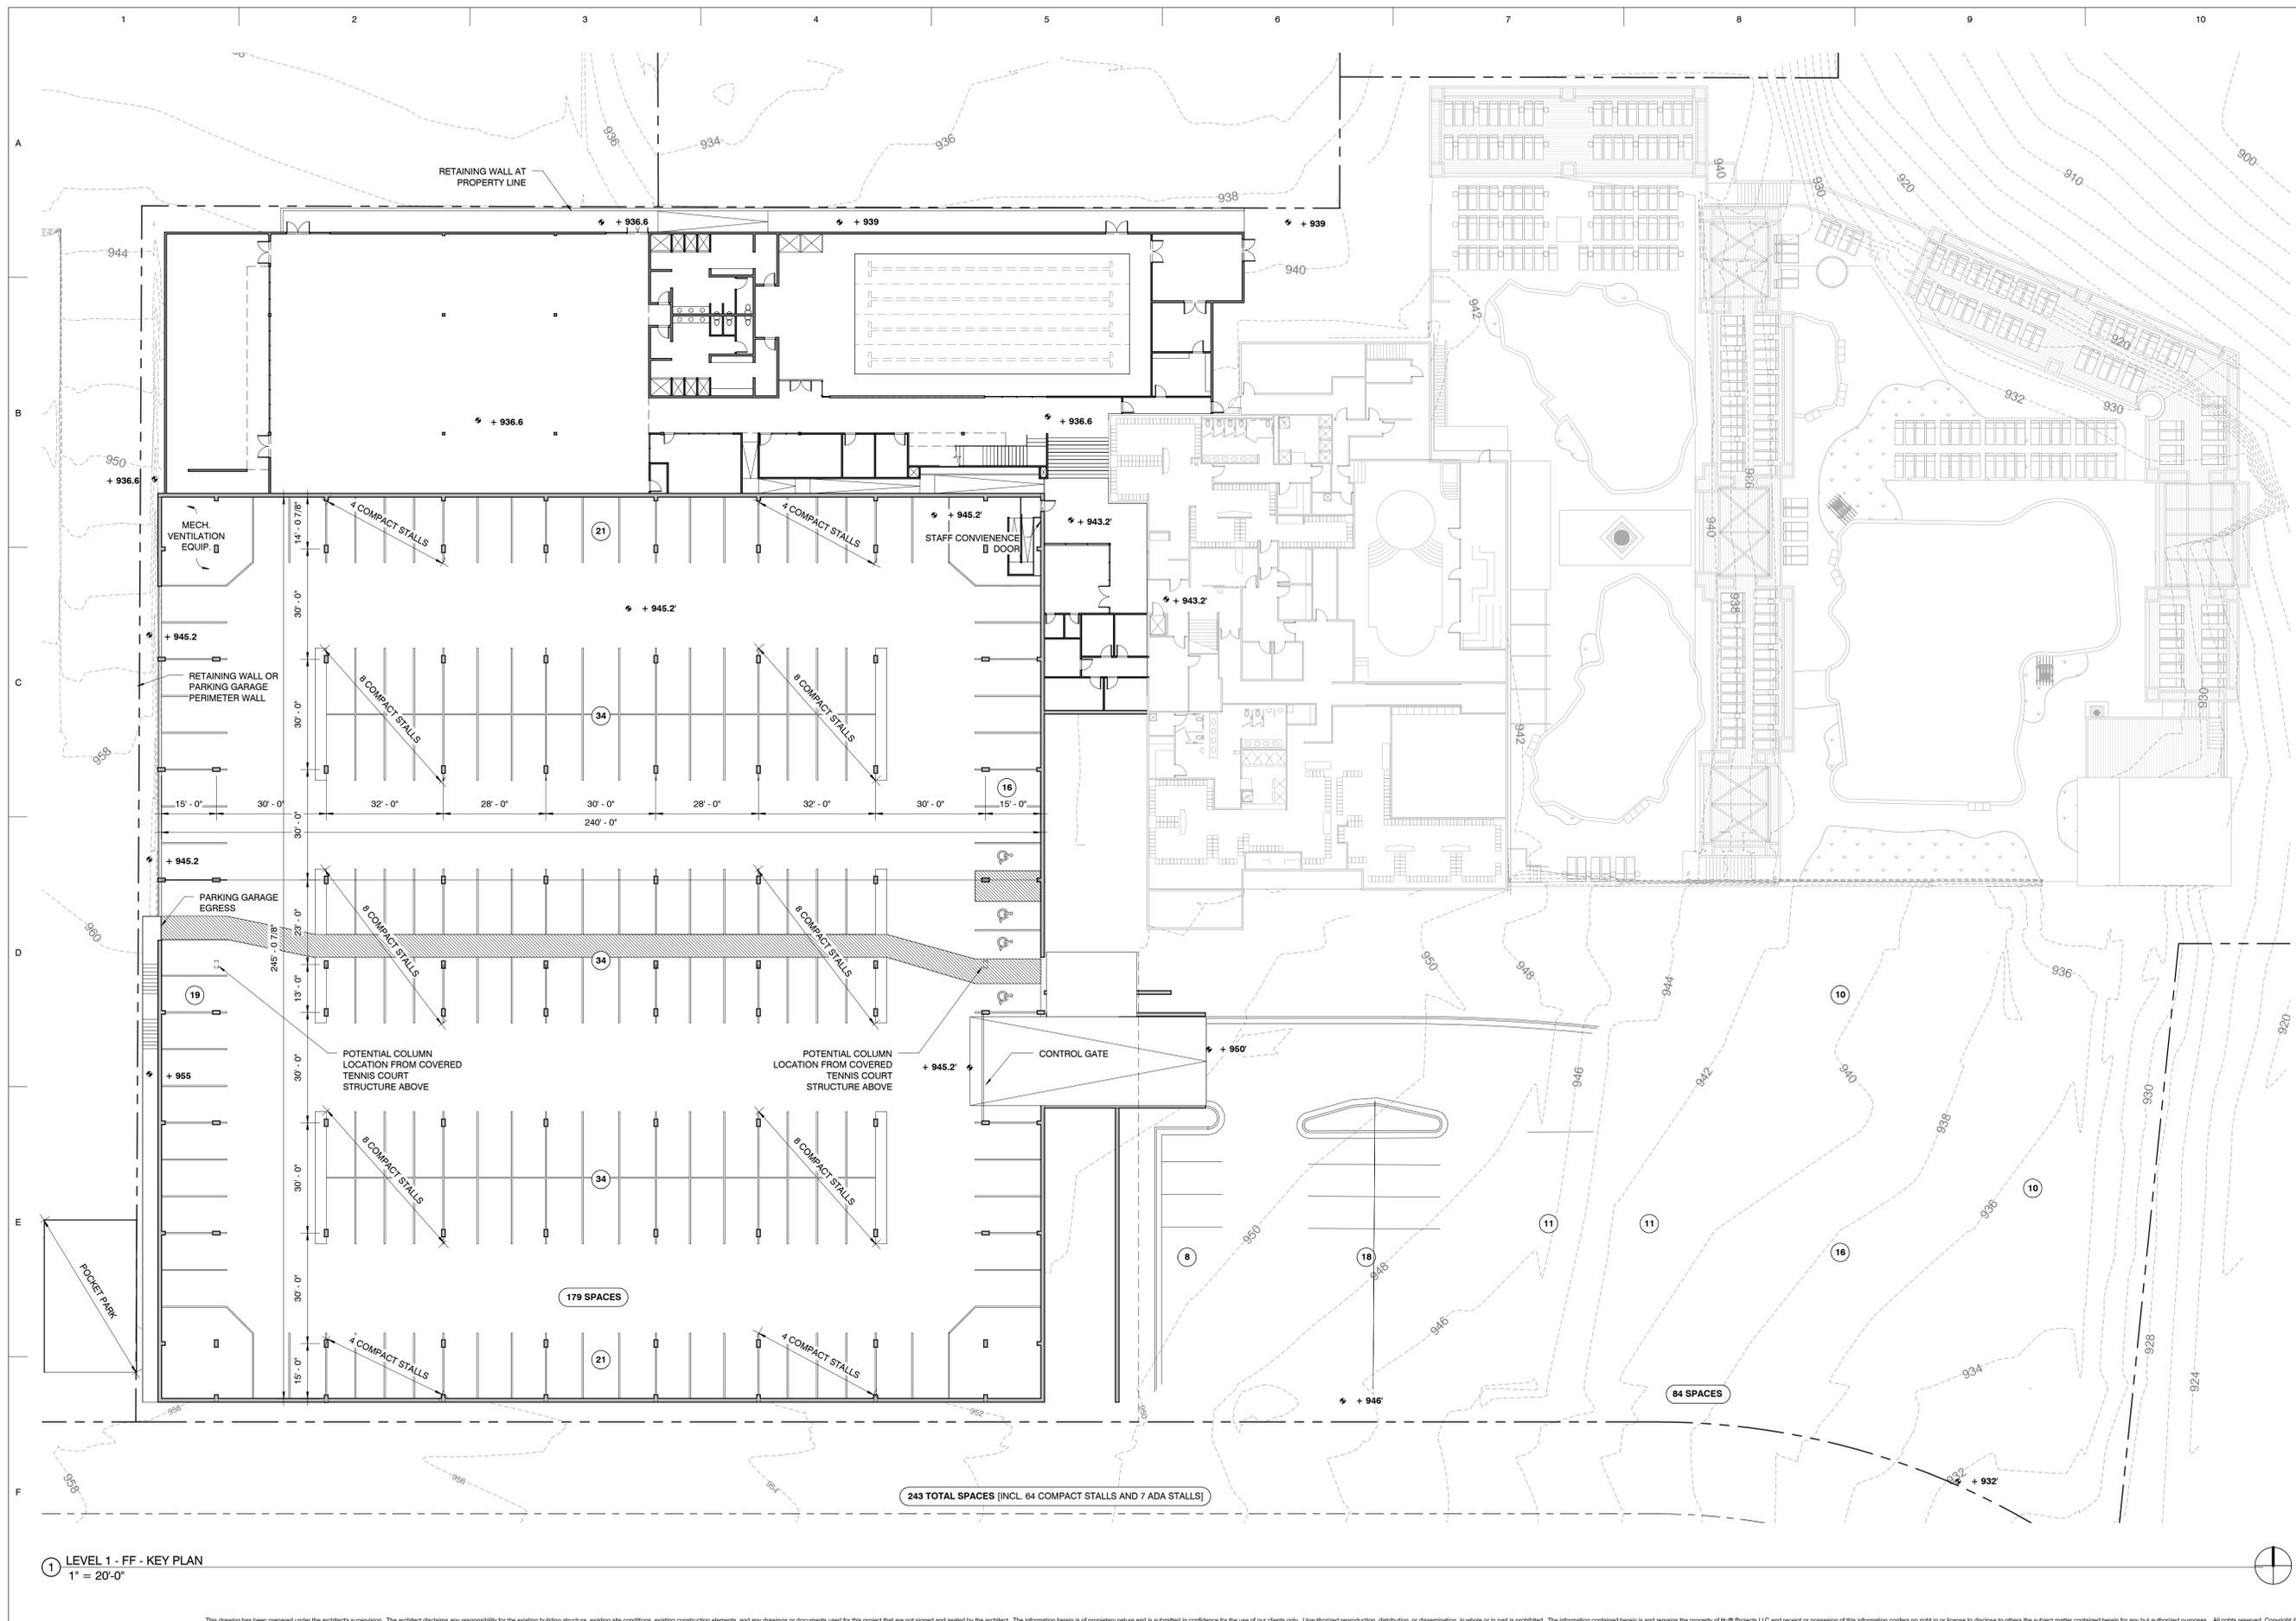
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LOWER LEVEL KEY PLAN

NUMBER:


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1 LEVEL 1 - FF - KEY PLAN
 1" = 20'-0"

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① LEVEL 2 - FF - KEY PLAN
 1" = 20'-0"

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 UPPER LEVEL KEY PLAN

NUMBER:
A202

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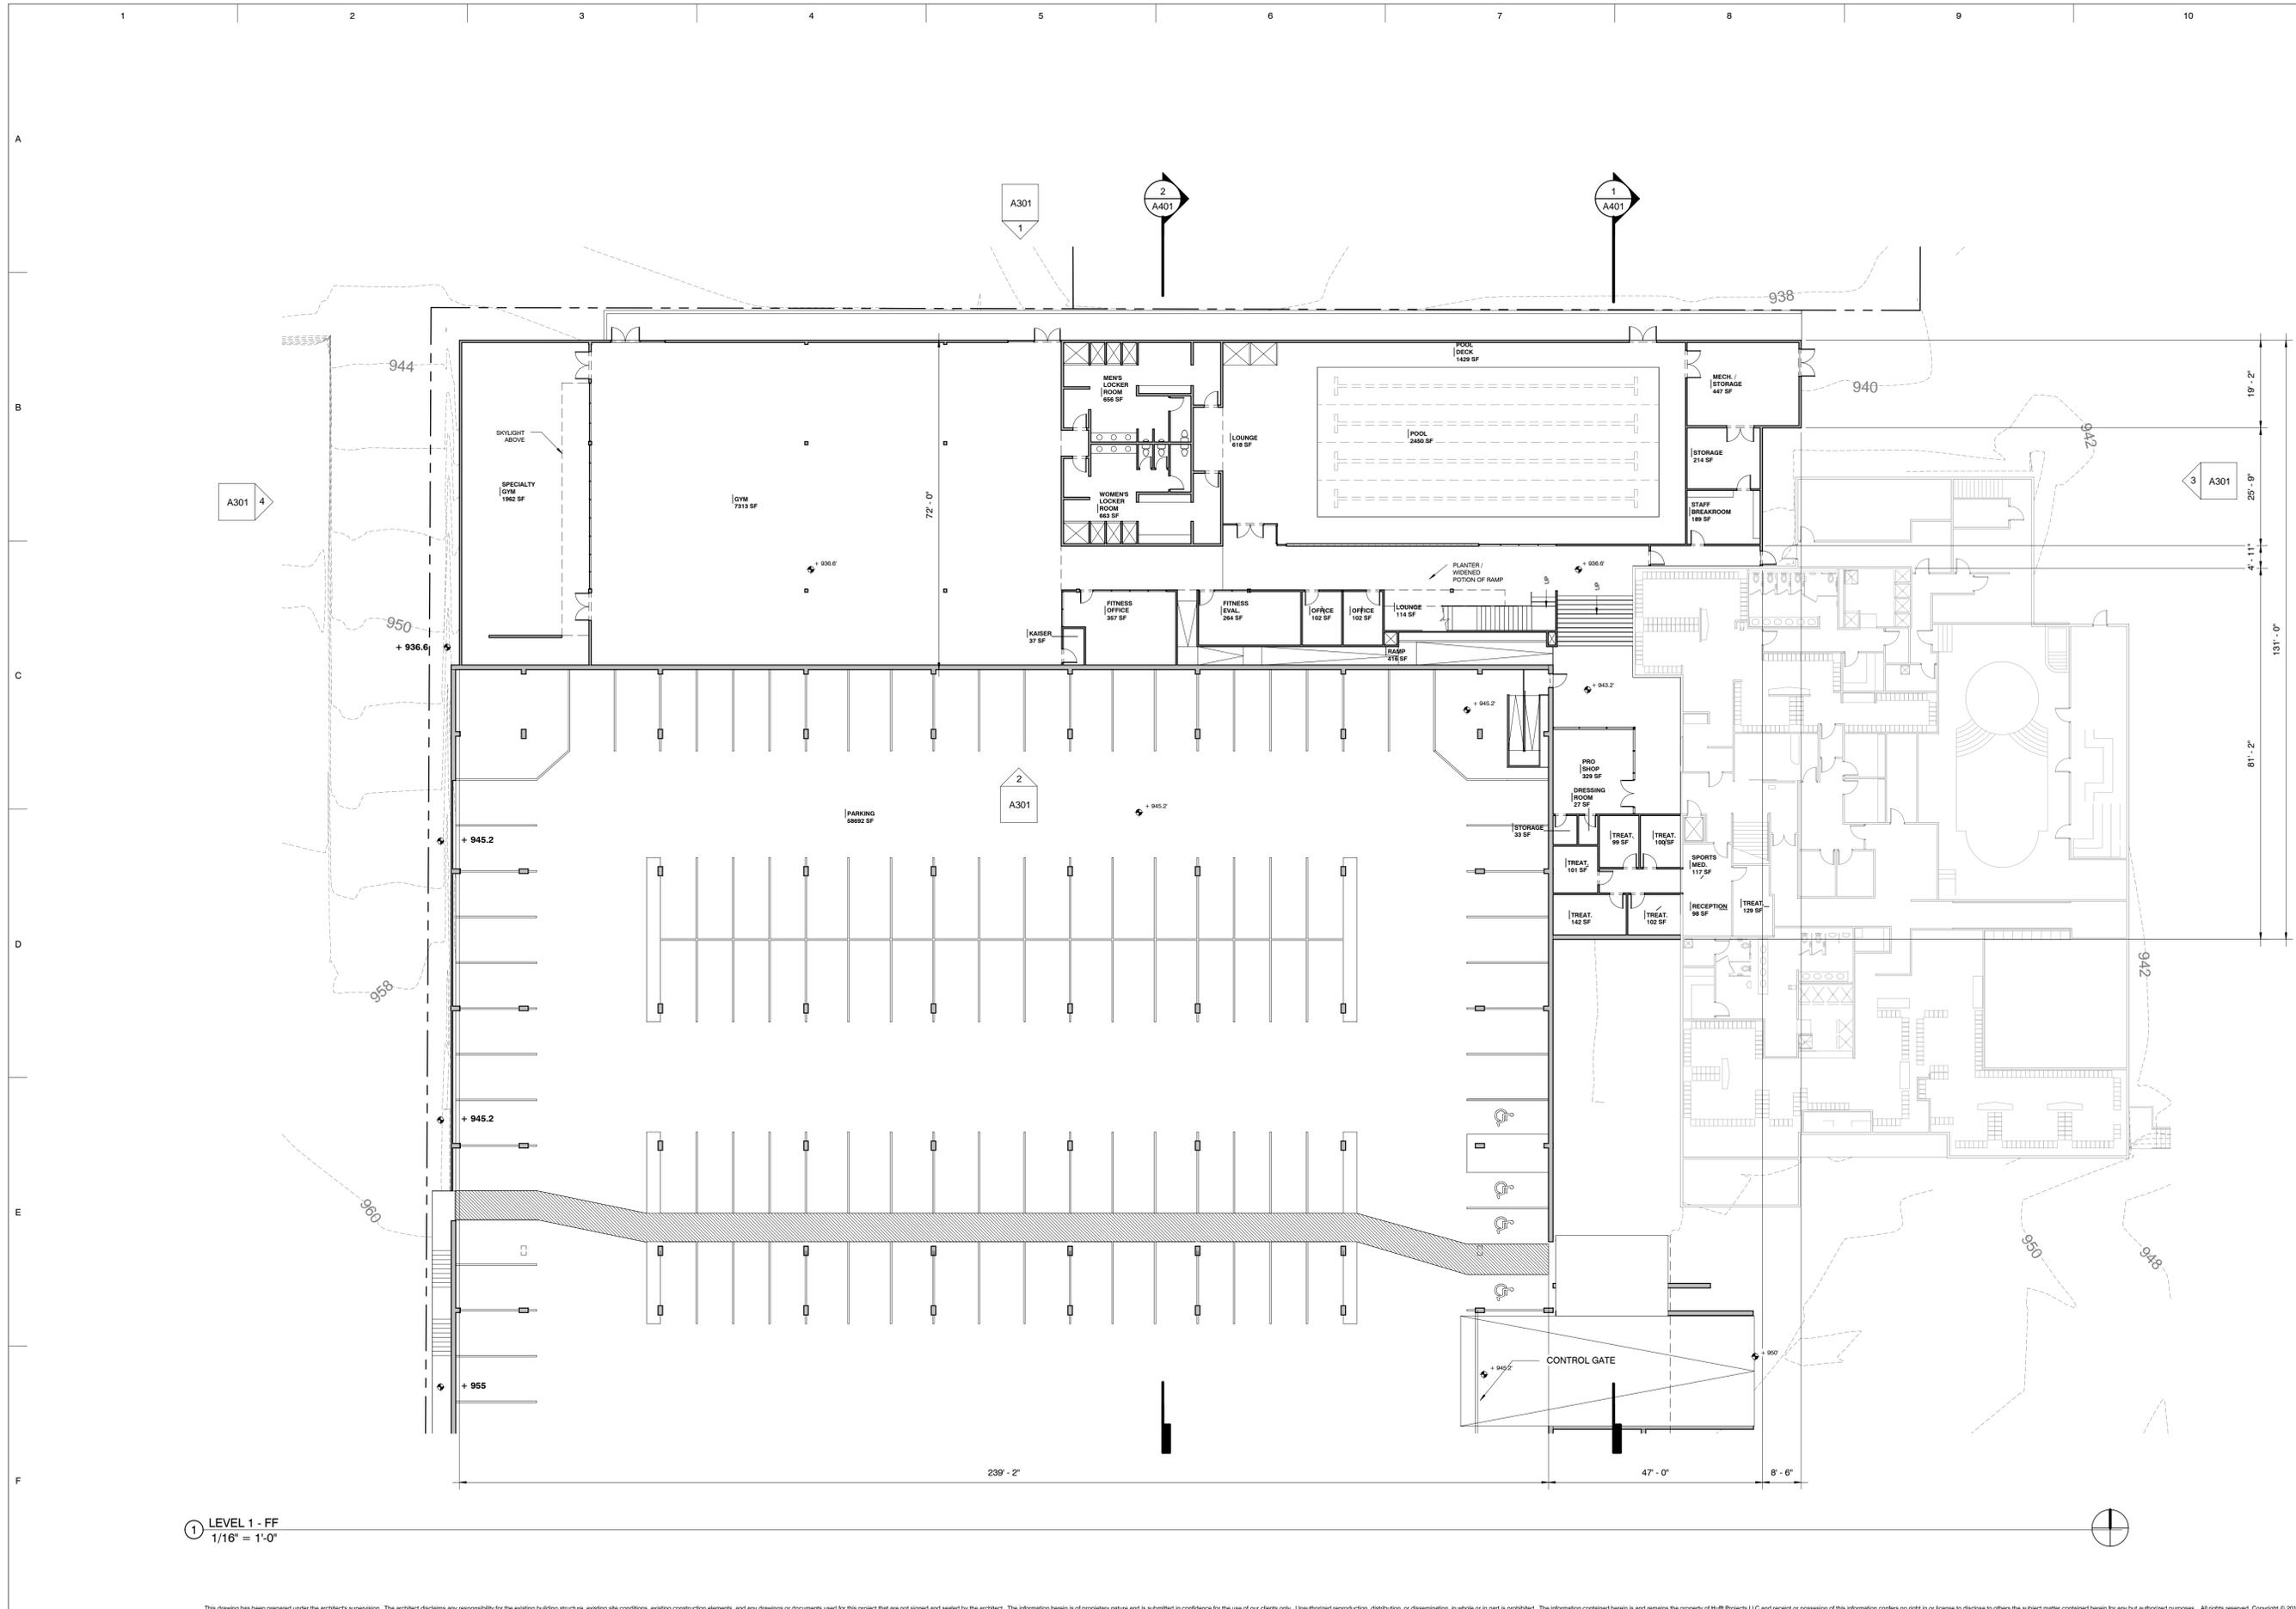
NOT FOR CONSTRUCTION

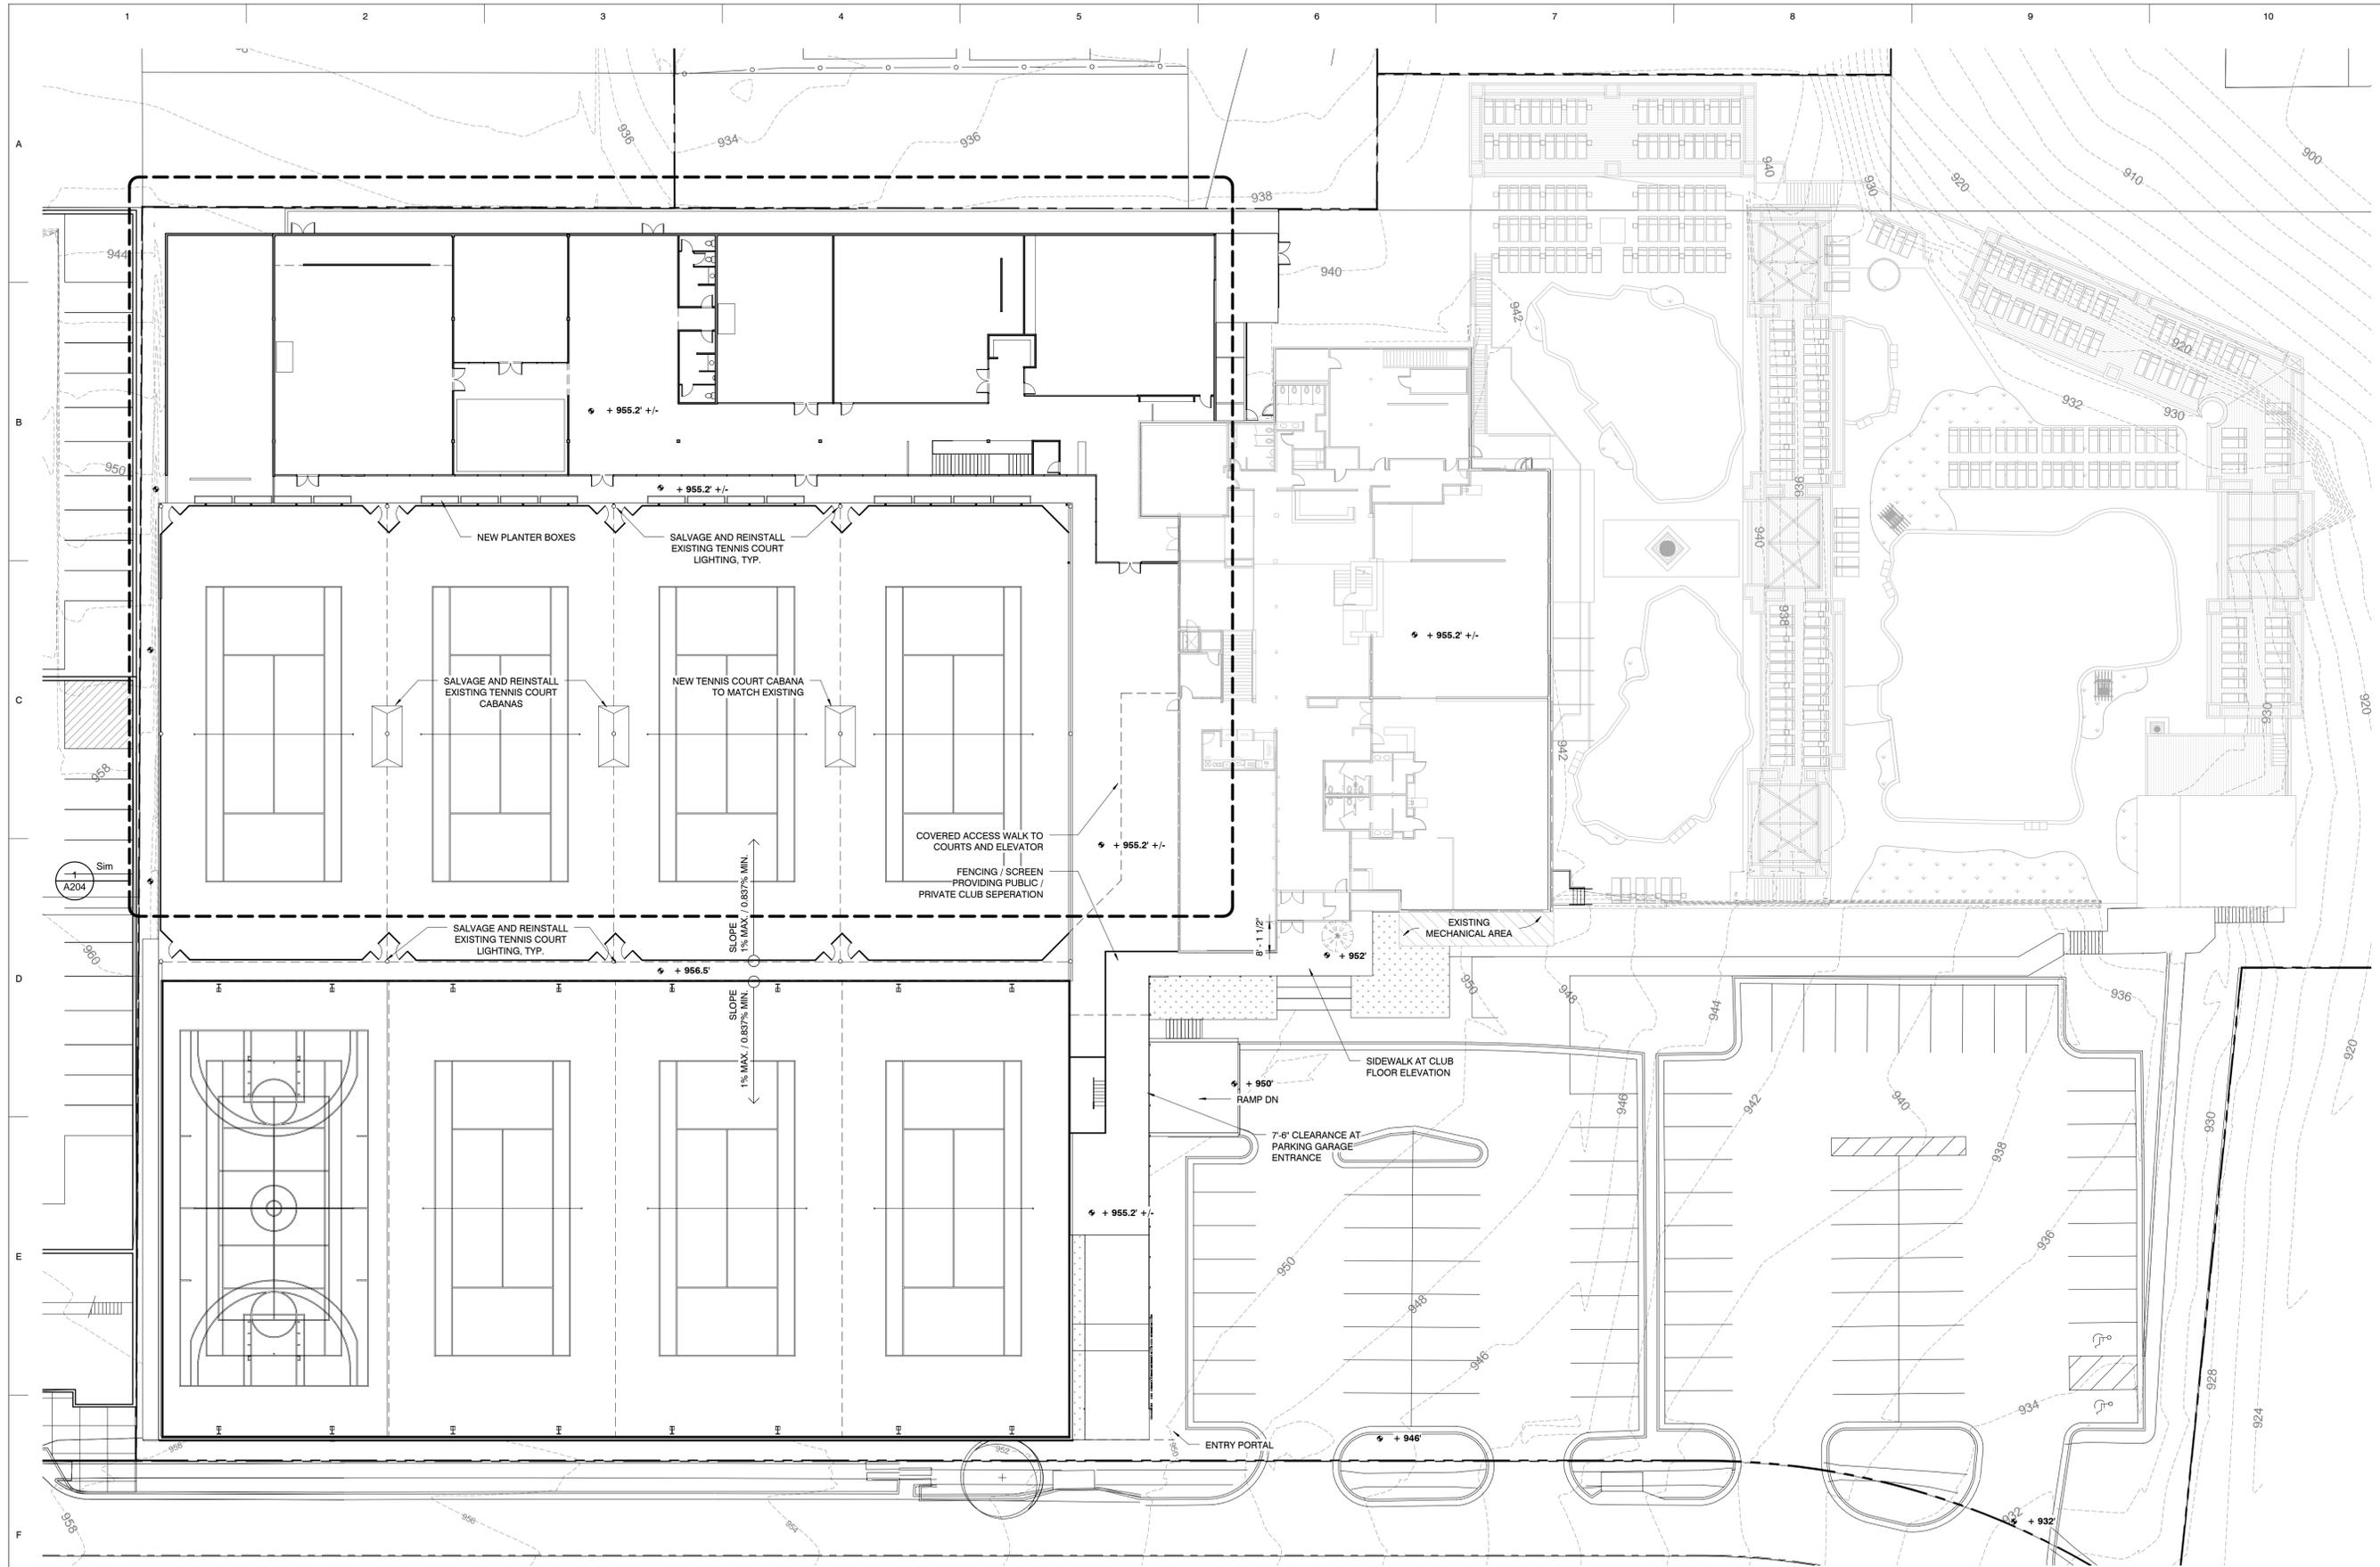TITLE:
 Drawn By: JDT
 Project Number: 10114

LOWER LEVEL PLAN

NUMBER:


A203




① LEVEL 1 - FF
 1/16" = 1'-0"

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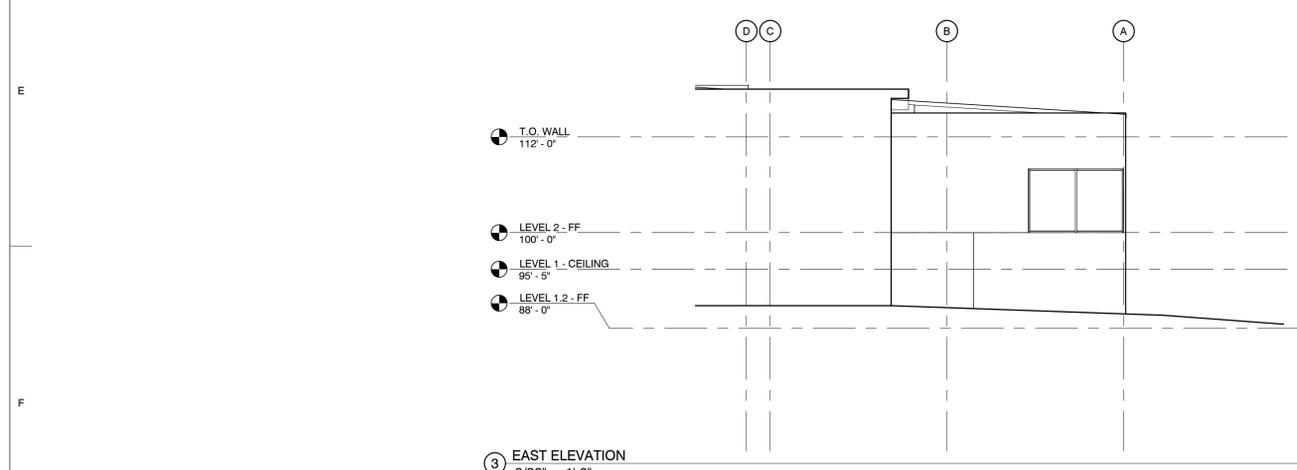
ARCHITECT:
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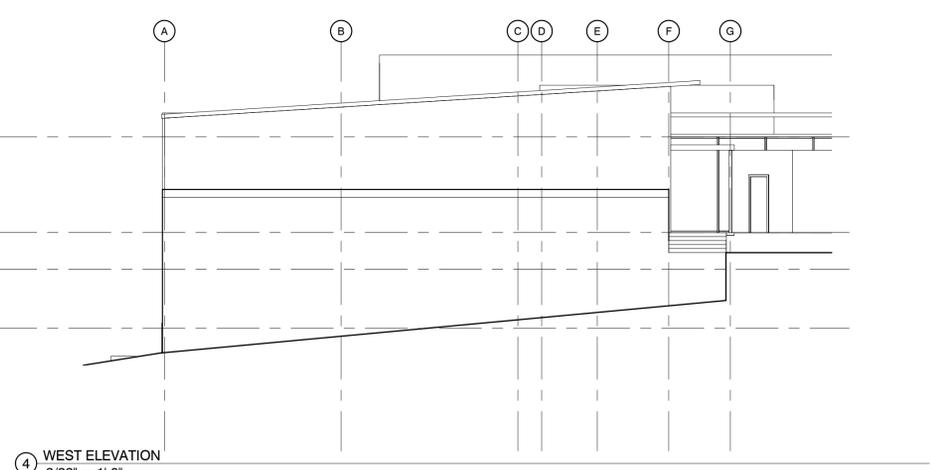
① NORTH ELEVATION
 3/32" = 1'-0"

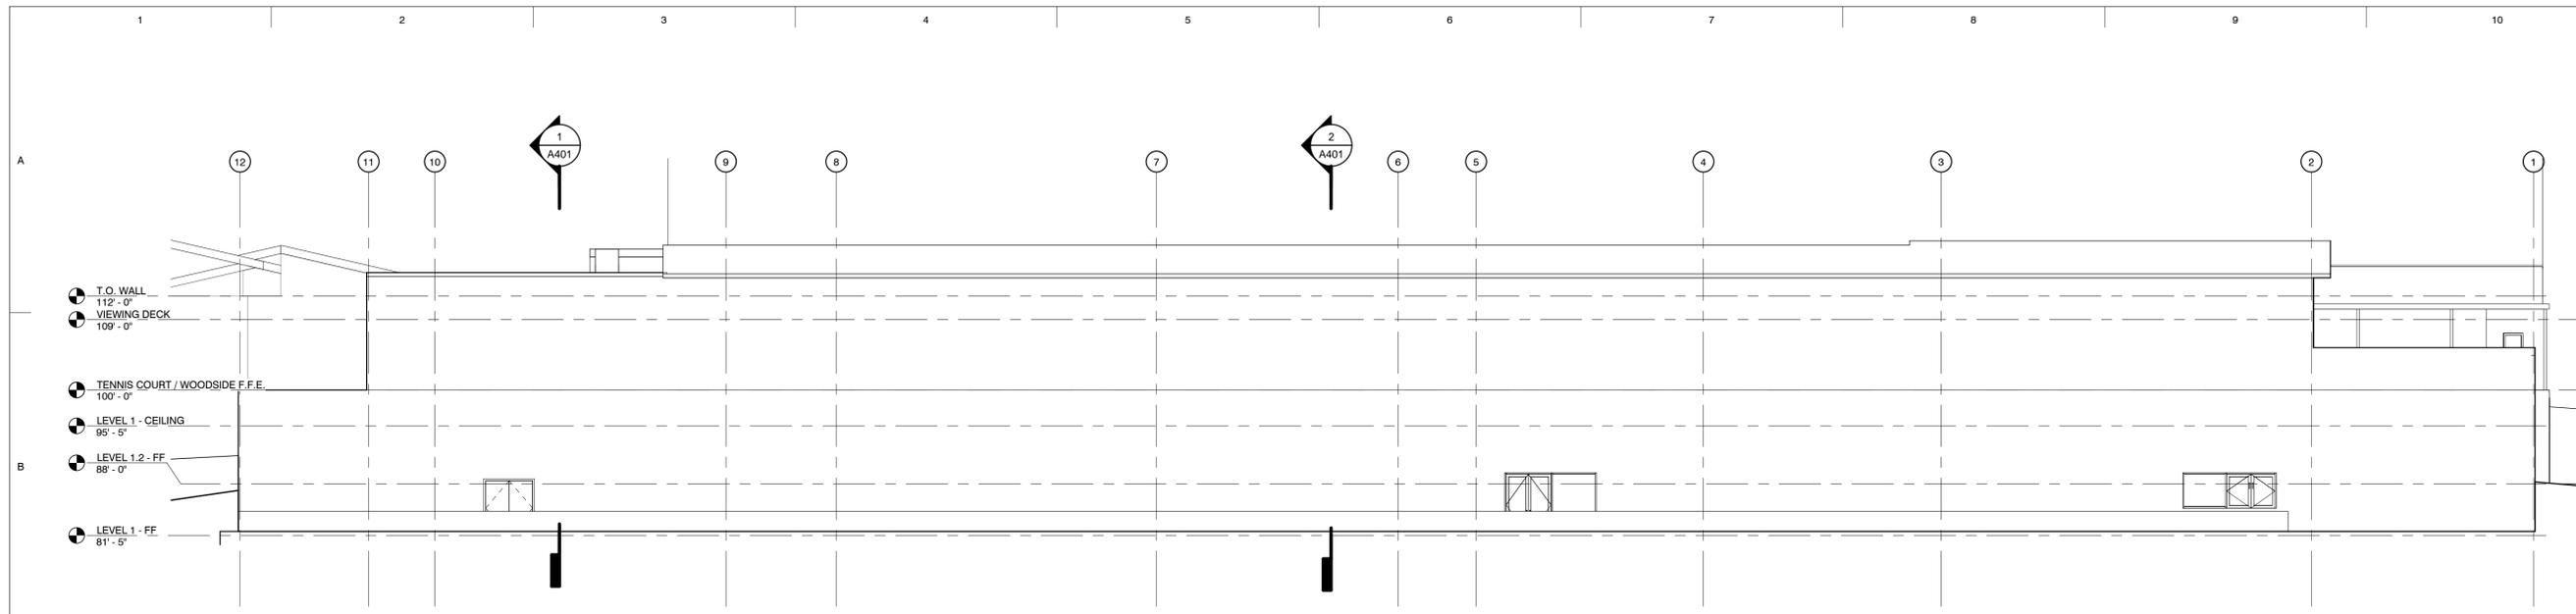

② SOUTH ELEVATION
 3/32" = 1'-0"

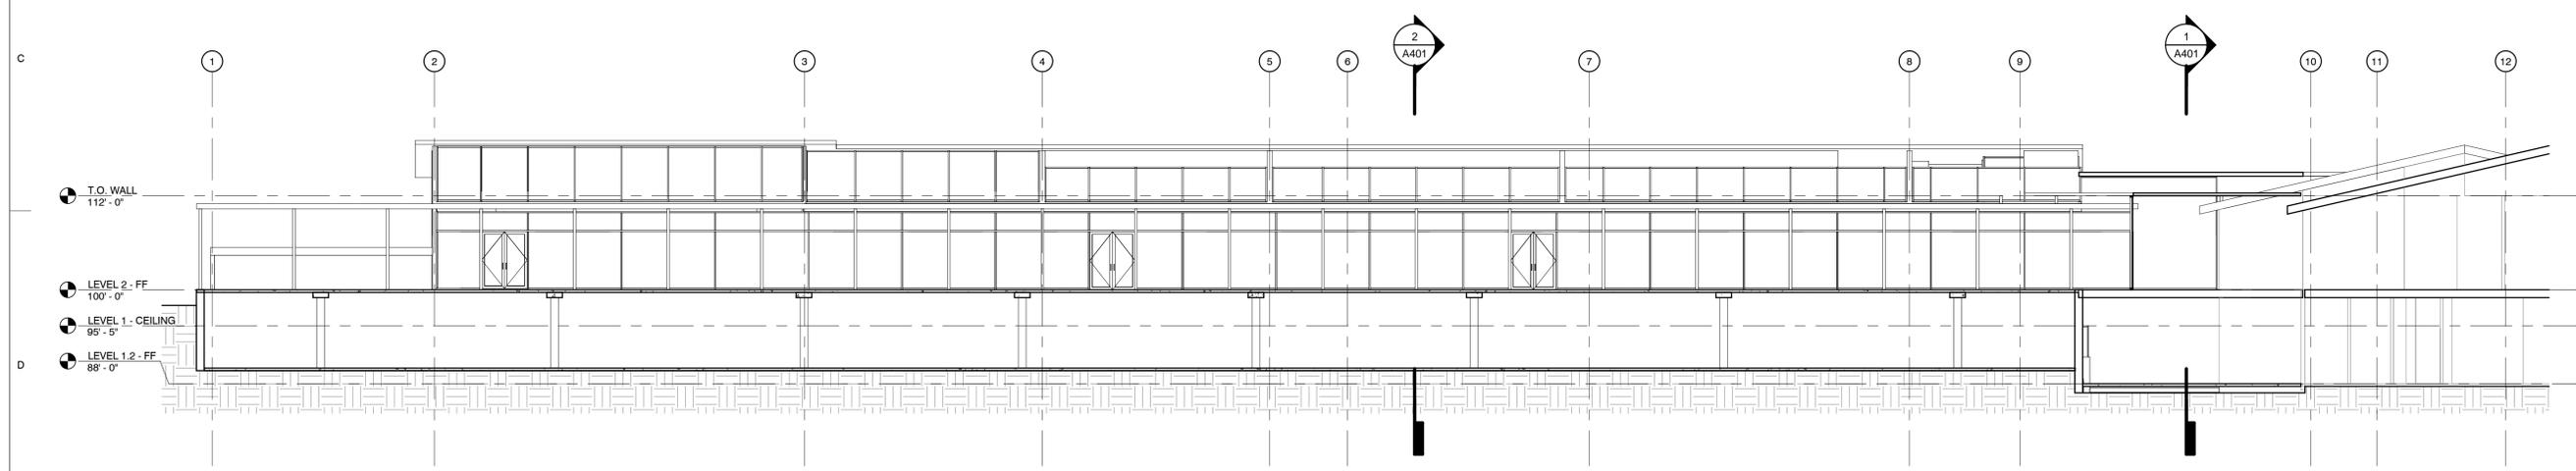

③ EAST ELEVATION
 3/32" = 1'-0"



④ WEST ELEVATION
 3/32" = 1'-0"

REVISION SCHEDULE:

NO.	DATE	ISSUE

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TITLE:
 Drawn By: JDT
 Project Number: 10114

ELEVATIONS

NUMBER:

A301

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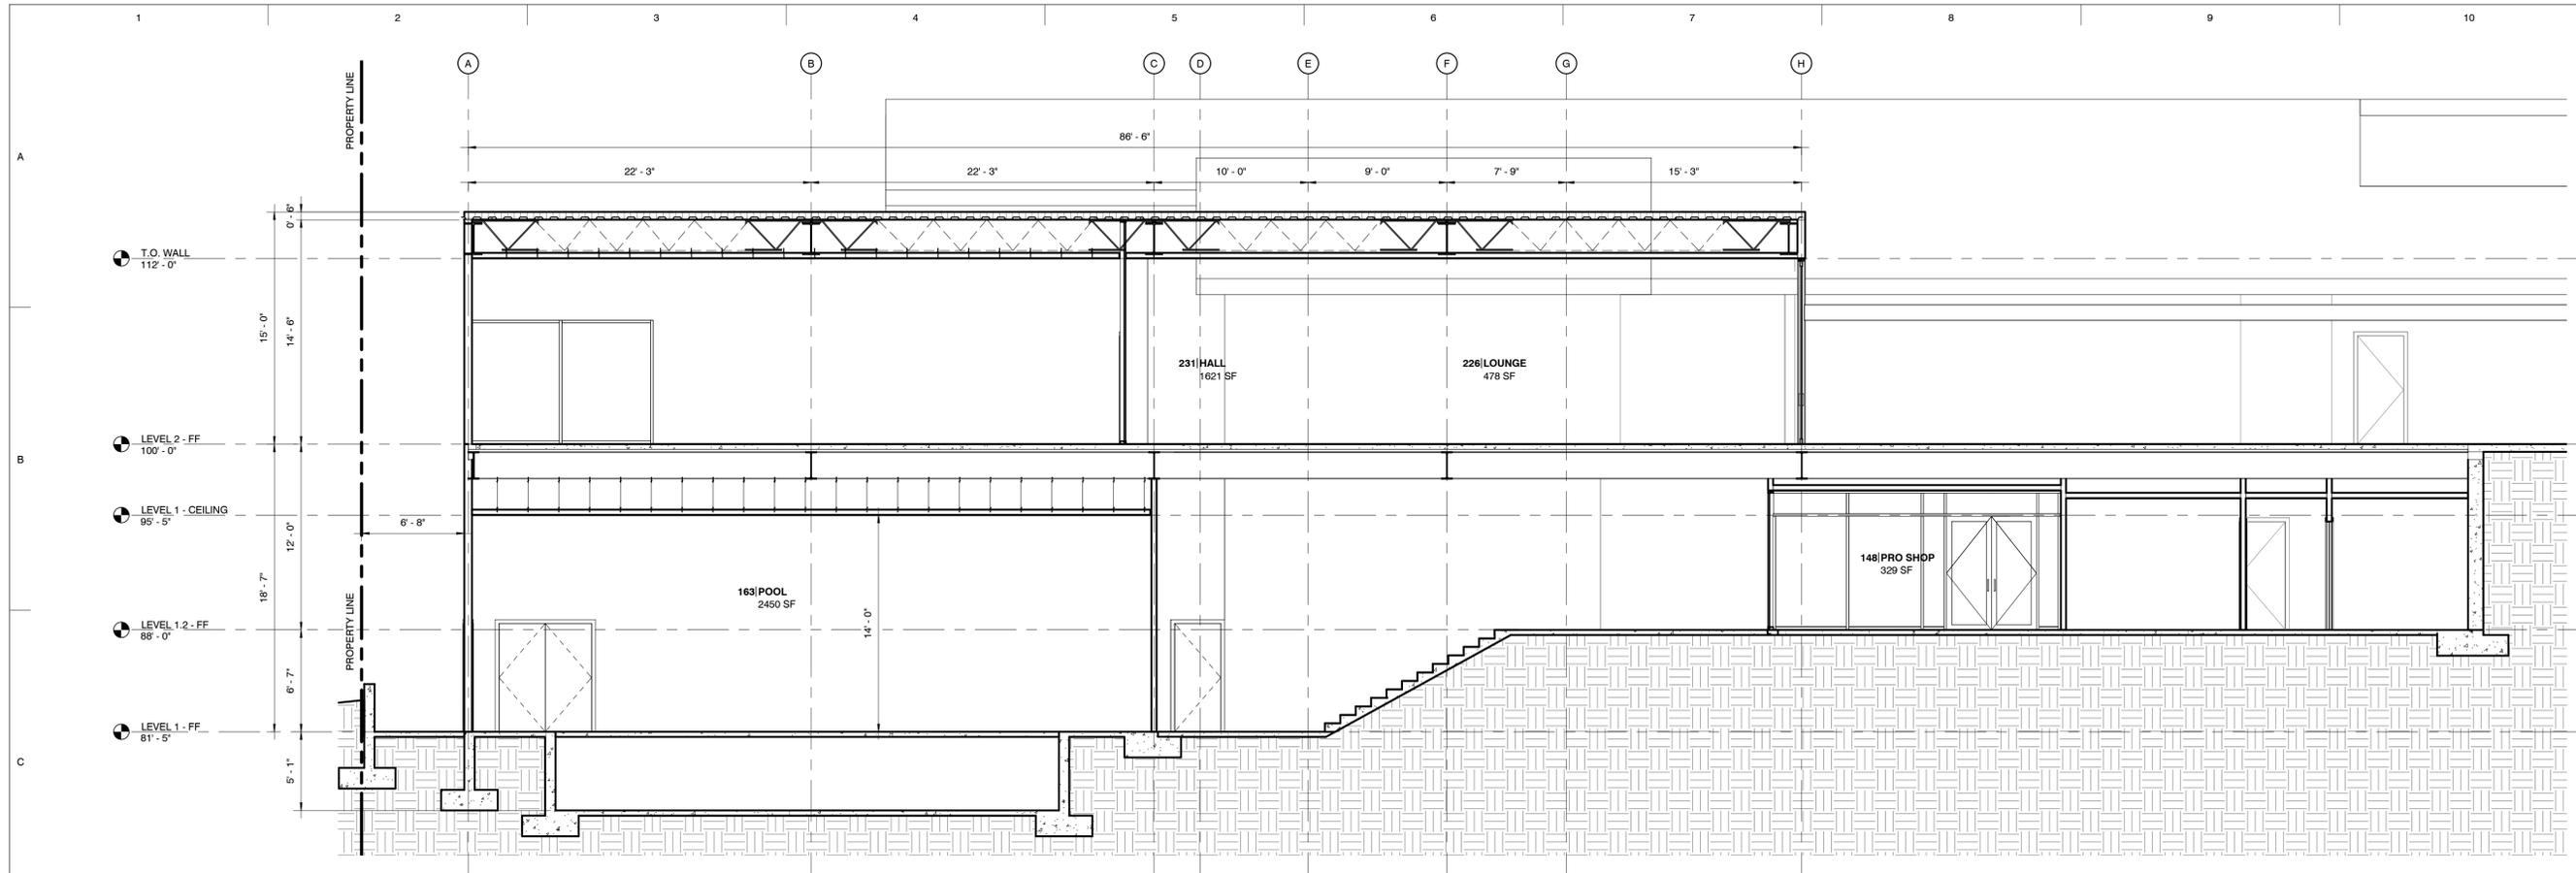
NOT FOR CONSTRUCTION

TITLE:
 Drawn By: JOT
 Project Number: 10114


SECTIONS

NUMBER:

A401



1 TRANSVERSE SECTION - 1
 3/16" = 1'-0"

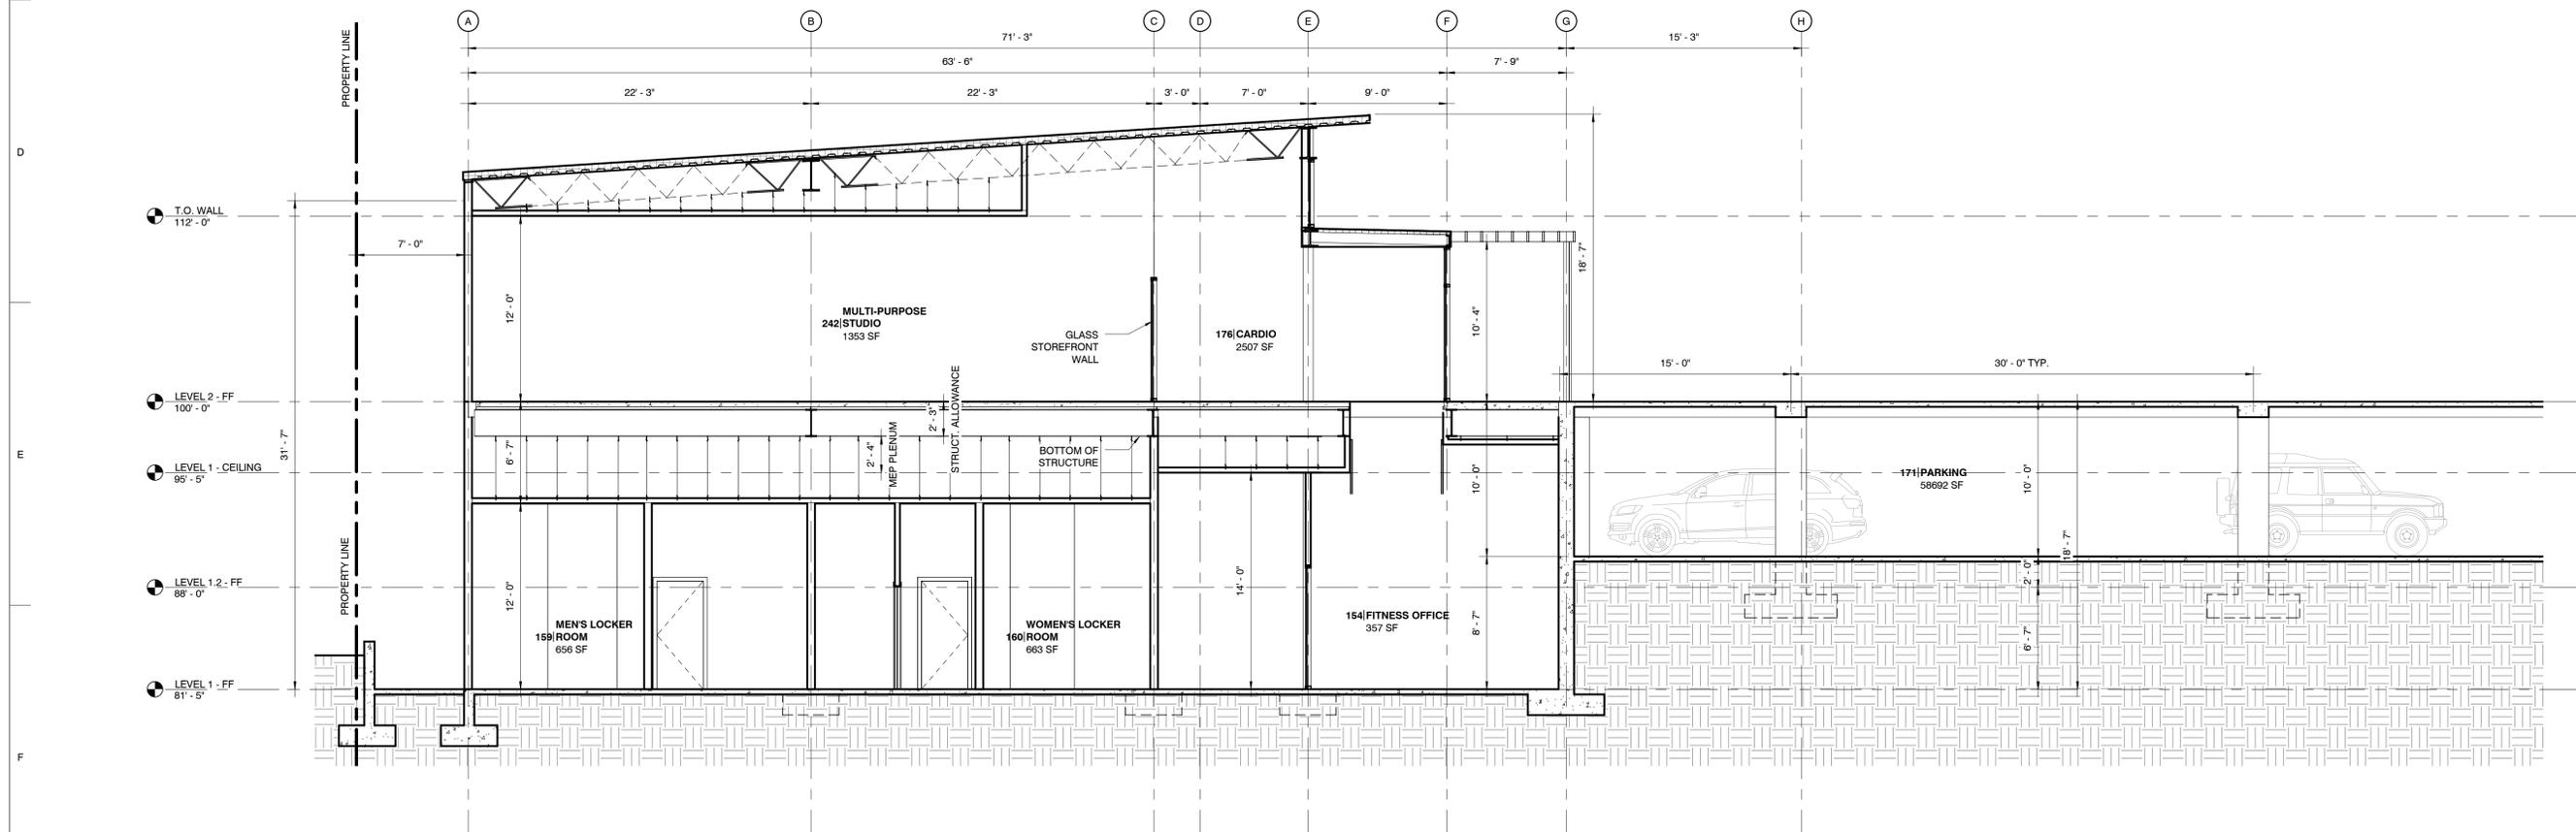

2 TRANSVERSE SECTION - 2
 3/16" = 1'-0"

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